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SHEET 3 - GENERAL NOTES/ESTIMATE OF QUANTITIES

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SHEET 6 - STANDARD TRAFFIC CONTROL NOTES & DETAILS

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CITY OF ABILENE, TEXAS PUBLIC WORKS DEPARTMENT

ENGINEERING DIVISION

PROJECT LENGTH APPROXIMATE 949' BRIARWOOD AND N. 3RD ALLEY CONSTRUCTION

SHANE PRICE

COUNCIL

JACK RENTZ

KYLE MCALISTER

WELDON HURT

TRAVIS CRAVER


DONNA ALBUS

ANTHONY WILLIAMS

MAYOR

CITY MANAGER

ROBERT HANNA

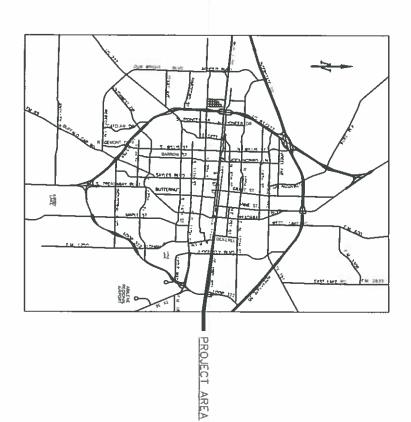

PROJECT LOCATION MAP

DIRECTOR OF PUBLIC WORKS

GREGORY S. McCAFFERY, P.E.

FUNDING:
ACTIVITY NUMBER: 5006
PROJECT DURATION: 20 WORKING DAYS REVISED SEPTEMBER 2006 SPEC

CIFICATIONS USED FOR THIS PROJECT ARE FROM THE

ABILENE STANDARD SPECIFICATIONS FOR CONSTRUCTION"
ADOPTED JANUARY 2001

compliance with Texas Accessibility standards and the Americans with Disabilities Act. $\stackrel{\triangle}{=}$ curb ramps and pertinent designs are in reasonable


EROSION CONTROL REQUIREMENTS:

way are still necessary. Questions concerning these requirements A determination has been made that this project/development is not subject to the requirements of the Texas Commission on Environmental Quality TPDES Construction General Permit TXR150000 as it will involve less than one acre of disturbed soil and is not part of a larger common plan of development equal to or greater than one acre. However, City of Abilene may be addressed to the City of Abilene's Engineering Division at 325.676.6281. requirements for an erosion control plan and implementation of



INTERIM CITY ENGINEER

CHARLIE THOMAS, P.E

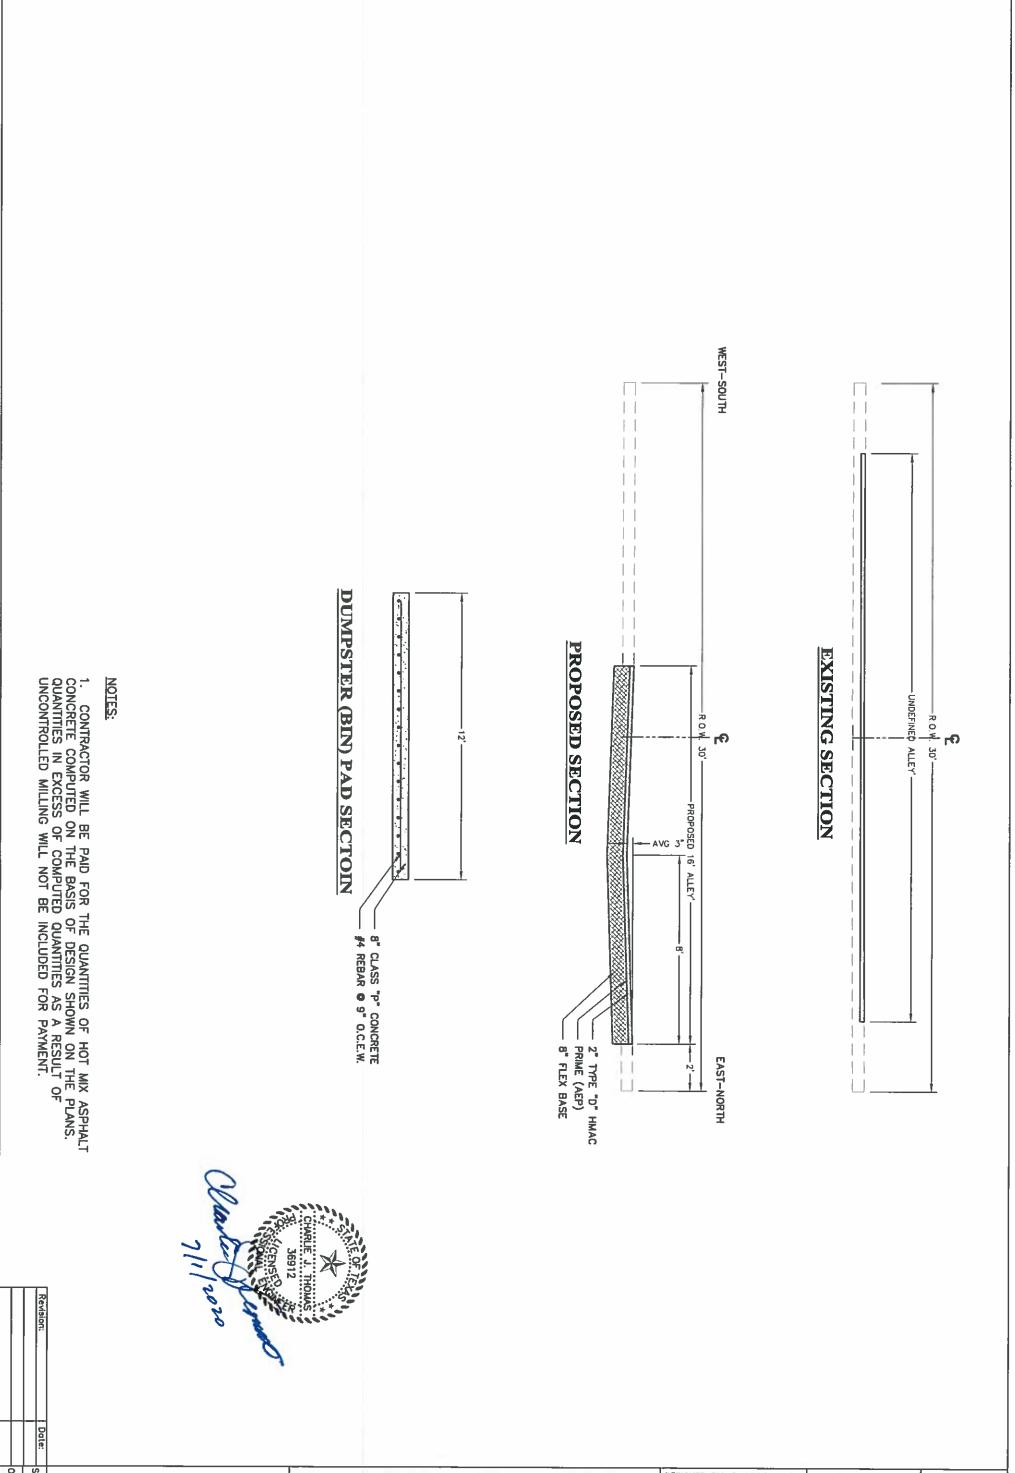

SHEET 2

CITY OF ABILENE, TEXAS PUBLIC WORKS DEPT./ENGINEERING DIV.

BRIARWOOD AND N. 3RD ALLEY CONSTRUCTION TYPICAL SECTIONS

DESIGNED BY: D. MUNDSCHENK HORIZ. SCALE: 1:40 DRAWING NAME:

DRAWN BY: D. MUNDSCHENK VERT. SCALE: NONE 5006

CHECKED BY: C. THOMAS DATE: 7/2020

ACCESS TO RESIDENCES AND BUSINESSES SHALL BE PROVIDED AT ALL TIMES

- THE CONTRACTOR SHALL APPOINT, IN WRITING, A SUPERINTENDENT FOR THIS PROJECT. THE SUPERINTENDENT SHALL BE AVAILABLE AT ALL TIMES.
- 3. CONTRACTOR MUST COORDINATE ONGOING CONSTRUCTION WITH OTHER CONSTRUCTION WITHIN THE LIMITS OF THE PROJECT AND ALTER HIS OPERATION AS NECESSARY.
- 4. ITEM 340 HOT MIX ASPHALT CONCRETE PAVEMENT. PROVIDE HOT MIX ASPHALT CONCRETE IN ACCORDANCE WITH CITY OF ABILENE STANDARD SPECIFICATIONS FOR CONSTRUCTION 2006, HOT MIX CAN ONLY BE LAID THE WEATHER CONDITIONS ARE FAVORABLE, THE CONTRACTOR MAY STOCKPILE HOT-MIX AND RE-HANDLE IT. CARE SHOULD BE EXERCISED, HOWEVER, TO PREVENT THE MIX FROM COOLING BELOW 270 DEGREES STOCKPILES ON ANY OF THE NEWLY PLACED SURFACES. A STOCKPILE AREA INDEPENDENT OF THIS PROJECT WILL BE SELECTED. NO JOINTS WILL BE PERMITTED IN WHEEL PATHS. ASPHALT PAVEMENT WILL NOT BE PLACED IN
- THE TOTAL 7 SACKS EQUIVALENT WILL NOT CONTAIN MORE THAN 20% FLY ASH
- 5. ITEM 350 CONCRETE PAVEMENT. FOR THIS PROJECT, THE MIX DESIGN WILL BE MODIFIED TO INCREASE THE MINIMUM SACKS OF CEMENT FROM 5 SACKS TO 7 SACKS EQUIVALENT. THE MAXIMUM SLUMP REQUIREMENT WILL BE 4". THE PERCENT OF AIR ENTRAINMENT WILL BE 3-5%. A NORMAL OR MEDIUM WATER REDUCERS WILL BE USED.

 THE CONCRETE IS TO BE REINFORCED WITH #4 BARS © 9" O.C.E.W.. THE PAVEMENT SURFACE IS TO HAVE A LIGHT METAL TINE FINISH. REFLEX RECYCLED RUBBER EXPANSION JOINTS ON THIS PROJECT. THE CONTRACTOR MAY OPEN THE NEWLY PLACED CONCRETE PAVEMENT UP TO NORMAL THE CONTRACTOR WILL PAY THE COST OF TEST CYLINDERS THAT ARE BROKEN EARLIER THAN SEVEN (7) DAYS. JOINT FILLER FOR CONCRETE MANUTRAFFIC WHEN STANDARD COMPRES
- 6. ITEM 423 FAST TRACK CONCRETE. FOR THIS PROJECT THE CONTRACTOR SHALL USE FAST TRACT CONCRETE FOR THE TWO ALLEY APPROACHES DUE TO THE TIMING WASTE DEPARTMENT FOR PICKUP TIMING. THE CONCRETE IS TO BE REINFORCED WITH #4 BARS © 18" O.C.E.W.. OF THE SOLID WASTE PICK UP SCHEDULE. CONSTRUCTION EQUIPMENT AND SUPPLIES TO THE OF THE PAYMENT BOND AND PERFORMANCE BOND CON TRACTOR IS TO COORDINATE WITH THE SOLID THE VICINITY OF PART OF THE
- 7. ITEM 500 MOBILIZATION. THIS ITEM SHALL GOVERN FOR THE ESTABLISHMENT OF OFFICE AND OTHER FACILITIES AT THE PROJECT SITE AND THE MOVEMENT OF PERSONNEL, THE PROJECT SITE IN ORDER TO ENABLE THE CONTRACTOR TO BEGIN WORK ON THE OTHER CONTRACT ITEMS THAT WILL BE PERFORMED BY THE CONTRACTOR. THE COST MOBILIZATION ITEM UNDER THIS CONTRACT. B. <u>ITEM 502 BARRICADES, SIGNS, AND TRAFFIC HANDLING.</u> THIS PROJECT REQUIRES THE CONTRACTOR IS TO INSTALL CONSTRUCTION BARRICADES, SIGNS, AND TRAFFIC HANDLING ON THIS PROJECT. THERE MAY BE OTH THAT ARE DEEMED NECESSARY TO PROTECT THE TRAVELING PUBLIC AND CONSTRUCTION EMPLOYEES. PAYMENT FOR MISCELLANEOUS MINOR SIGNS WILL BE INCLUDED IN THE PRICE BID FOR ITEM 502. <u>ALL TRAFFIC</u> WITH THE CURRENT TEXAS_MANUAL ON UNIFORM TRAFFIC CONTROL DEVICES (TMUTCD).

	BASIS O	BASIS OF ESTIMATE			
ITEM	DESCRIPTION	RATE	AREA	QUANTITY	TINU
310	PRIME (AEP)	0.25 GAL/SY	1625	407	GAL
340-1	HOT MIX ASPHALT, TYPE "D" (2")	220#/Sq.Yd.	1625	179	TON
	ESTIMATE (ESTIMATE OF QUANTITIES			
ITEM #	DESCRIPTION		TINU	TOTALS	S
100	PREPARE ROW		STA	9.5	
110 **	ROADWAY EXCAVATION (10")	10")	CY	536.25	
247	8" FLEX BASE - TYPE A, GRADE 5 (DEN CONT)	5 (DEN CONT)	YS	1625	
310	PRIME (AEP)		GAL	407	
340-1	HOT MIX ASPHALT CONCRETE (2")(TYPE D)(PG70-22)	PE D)(PG70-22)	NOT	[621	
360	CONCRETE PAVEMENT (CL "P") (B")	P") (8")	YS	311.5	
420	MANHOLE CONCRETE COLLAR (CL "A")(10"	L "A")(10")	EA	2	
424	FAST TRACT CONCRETE PAVEMENT	VEMENT	SY	94	
500	MÖBILIZATION		MO	1	
502	BARRICADES, SIGNS, & TRAFFIC HANDLING	HANDLING	MO		

310 CONTRACTOR SHALL PROVIDE 1-B CERTIFIED TECHNICIAN FOR ALL PAVING OPERATIONS TEX 207 IN PLACE AIR VOIDS (MAY USE CALIBRATED GAUGE WITH ENGINEER'S APPROVAL) 2 PER 500 TON=1 TXDOT PREQUALIFIED SOURCE ESTING REQUIREMENTS


A 20% QUANTITY FOR ROADWAY EXCAVATION HAS BEEN ADDED IN CASE OF SUBGRADE FAILURE.


NOTE **

CITY OF ABILENE, TEXAS PUBLIC WORKS DEPT./ENGINEERING DIV.

DESIGNED BY: D. MUNDSCHENK HORIZ. SCALE: 1:40 DRAWING NAME: DRAWN BY: D. MUNDSCHENK VERT. SCALE: NONE 5006 CHECKED BY: C. THOMAS DATE: 7/2020

BRIARWOOD AND N. 3RD ALLEY CONSTRUCTION GENERAL NOTES/ESTIMATE OF QUANTITIES

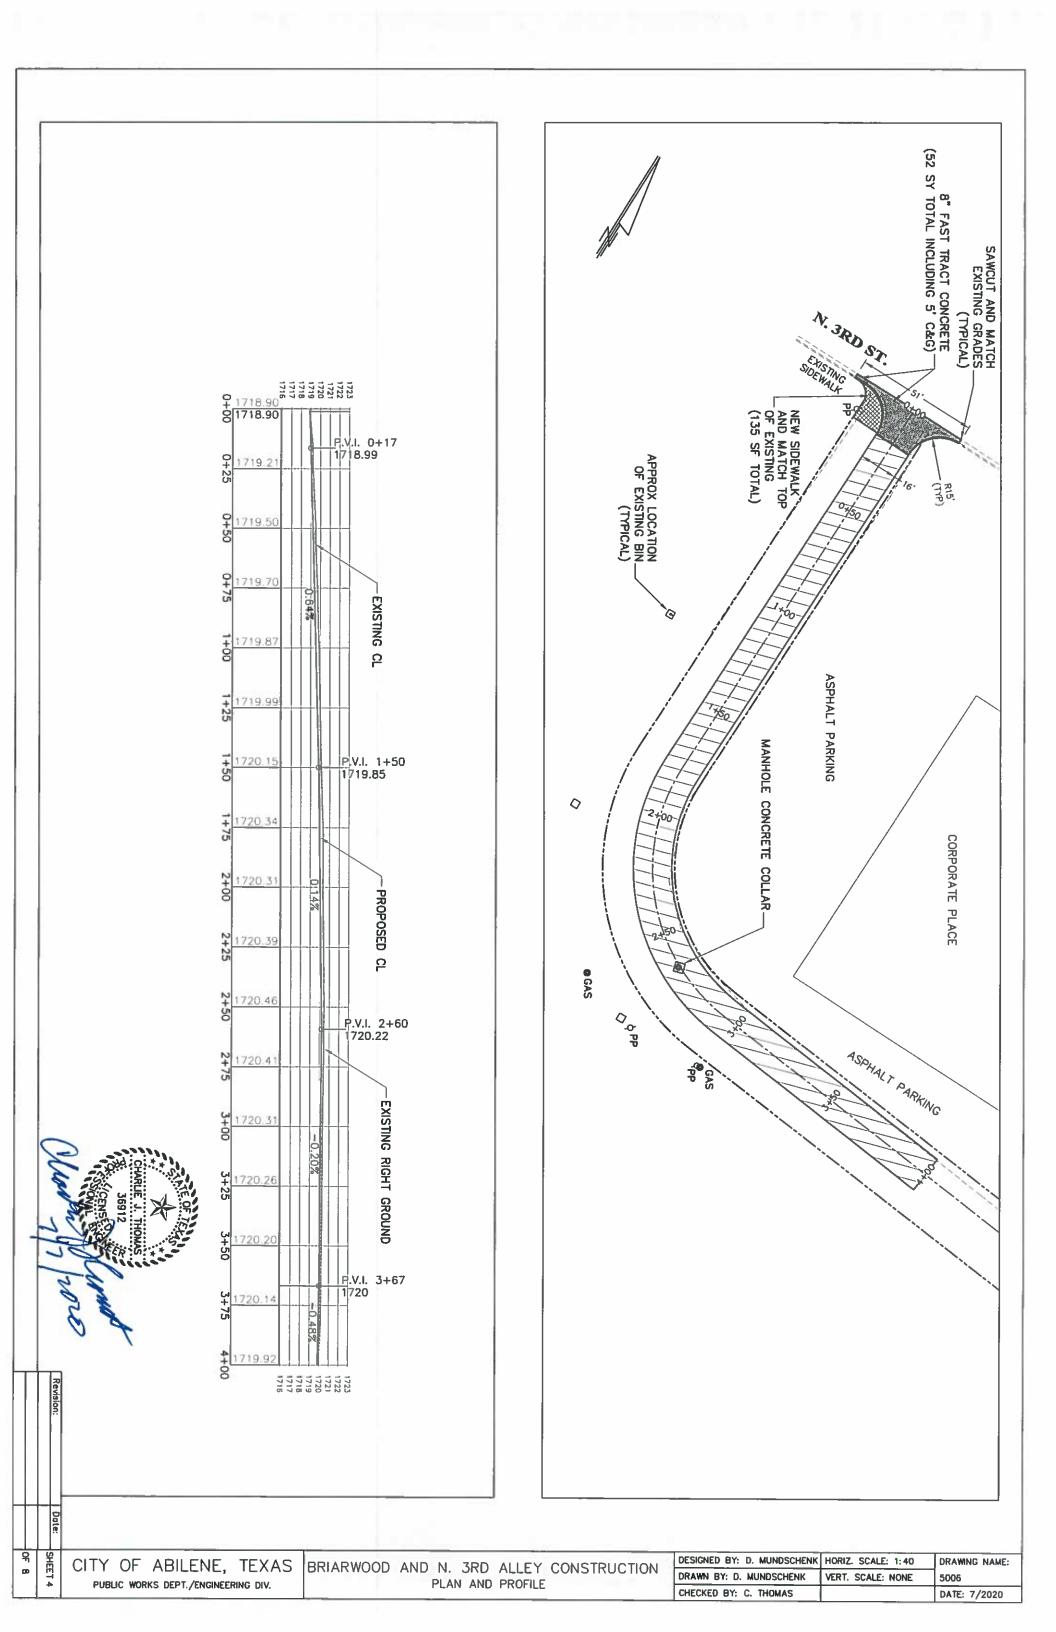

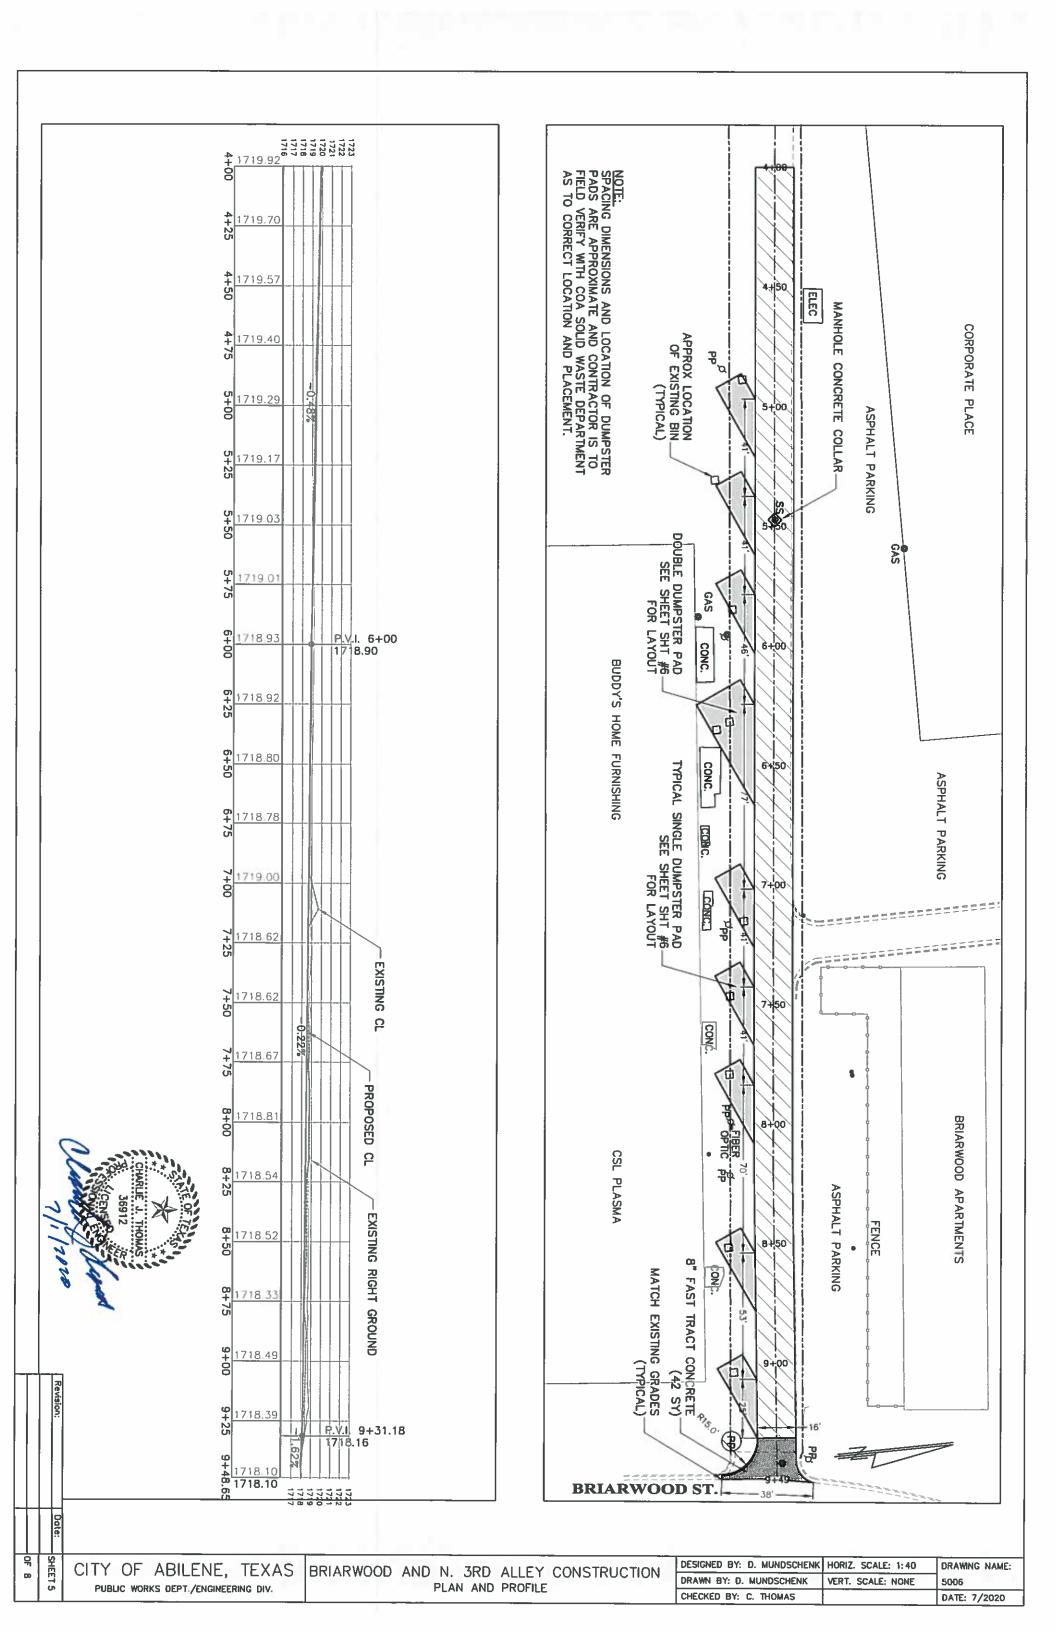

TRAFFIC CONTROL PLAN

The Contractor on this project will be required to submit a traffic control plan for each phase of this project. This plan will be in written or picture form and will be in compliance with the latest version of the Texas Manual on Uniform Traffic Control Devices for Streets and Highways (Part VI). Before work begins, the Traffic Control Plan has to be approved in writing by the Engineer. The approved plan will then become a part of

Any deviation from the approved Traffic Control Plan will void the acceptance of that plan and a corrected version will be submitted for approval.

No work will be performed until the Traffic Control Plan has been presented to the City of Abilene and has been approved in writing by the Engineer.

Any pedestrian routes that are affected by this project will require the same approval process as traffic. Pedestrian traffic that is moved from its normal path will be protected by an approved traffic control plan.

The Traffic Control Plan must have the following elements:

- 1. Carry two way traffic at all times.
- Work on one half of the street at a time.
- When work is performed across intersecting streets, handle traffic with flagmen or close street temporarily.
- All driveways will open the same day they are closed, unless approved otherwise.
- No residences will be denied access.
- 6. It is the Contractors responsibility to inform the residents a week in advance as to their plans. This will be done in writing and presented to the owner.

Merging

Upstream tapers

- At the end of each day, the Contractor will make an inspection of the work area and correct all deficiencies that may exist in the work area as well as construction signs.
- (C.R.P.) to work with Inspection Services and to see that the Traffic Control Plan is adhered to. This C.R.P. will be designated in writing and presented at the Preconstruction Conference. The Contractor will name a Contractor's Responsible Person
- When the job requires flagmen to control the traffic, that flagman will be equipped with a white hard hat and legal reflective vest as well as a legal traffic control paddle to direct traffic. The flagman will be a person that can clearly communicate with the motorists.

GENERAL TRAFFIC NOTES

- Appropriate standard traffic control devices shall be used within the project limits to adequately warn, advise, control and guide traffic around and/or through all areas of work activity, detours and other potentially hazardous locations as required by the plans.
- only. The traffic control devices used in the illustrations are examples only. Field conditions shall dictate the most appropriate traffic control devices to be used within a construction project.
- Traffic control devices shall be in place only while work is actually progress or a definite need exists.

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- to the early warning signs. Flashing warning lights and/or flags may be used to call attention
- Devices used in a series for channelization purposes shall be supplemented with steady burn lights or delineators at night (S

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4.

All traffic control devices used at night shall be reflectorized or illuminated.

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Formulas for taper are: $L = \frac{WS^2}{60}$ for speeds of 40 MPH or less

CONCRETE MEDIAN

BARRIER

L = WxS for speeds of 45 MPH or greater

Where: L = minimum length of taper

S = numerical value of posted speed limit prior to work or 85 percentile speed
W = width of offset

The taper types and the lengths of taper are as follows:


aper length


Downstream tapers Shoulder Shifting Two way traffic L min.
1/2 L min.
1/3 L min.
100' max.
100' min.


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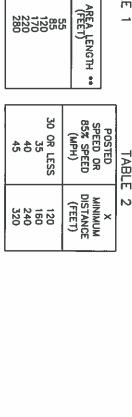
- The maximum spacing between channelizing devices in a taper section shall be approximately equal in feet to the speed limit. The maximum spacing between channelizing devices in a tangent section shall be approximately equal in feet to 2 to 2-1/2 times the speed limit.
- All distances and spacings shown are approximate. Field adjustment may be necessary for some signs and traffic control devices. All adjustments will be approved by the Engineer.

9



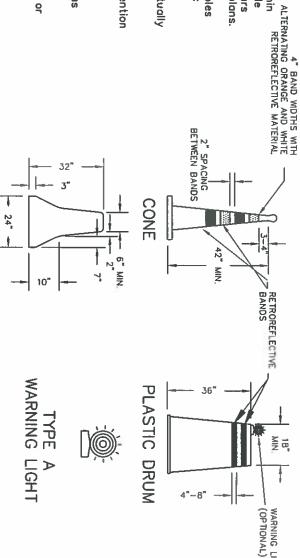

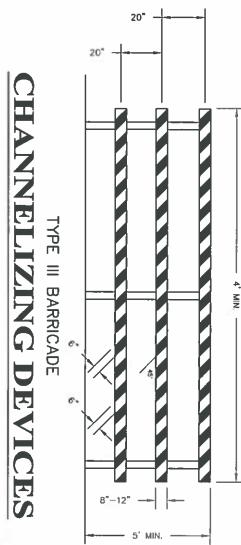

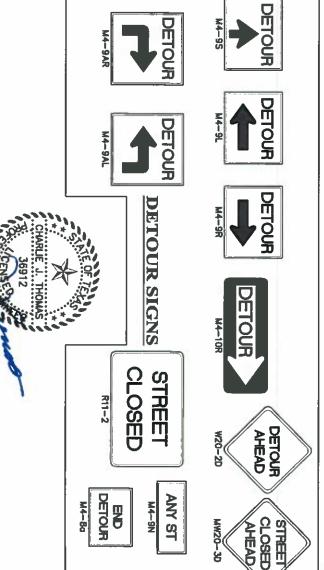

R4-88 R4-78

G20-2a

R11-2

R3-7R

R3-7L TURN LEFT LEFT LANE ISNM

ROAD CLOSED

1 MILE AHEAD

LOCAL TRAFFIC

ONLY

ROAD CLOSED
TO
THRU TRAFFIC

OBSERVE WARNING SIGNS STATE LAW

NAME ADDRESS CITY STATE

BUFFER

CONTRACTOR

R11-3a

R11-4

R20-3

2002440

2220255

WARNING SIGNS

CW20-7D

CW20-7A

CW21-40

CW6-3

CW20-5DR

CW20-50L

CW4-1gR

CW4-1oL

RATIC RESIGNATION RESIGNATION

EN REAL

POSTED SPEED

WORK WEAD

ROAD WORK

ROAD CLOSED

TURN RIGHT RIGHT LANE

** SUGGESTED LENGTHS MAY NEED TO BE INCREASED DEPENDING ON FIELD CONDITIONS AND GEOMETRY OF THE ROAD.

TABLE 1

HLS.

CITY OF ABILENE, TEXAS PUBLIC WORKS DEPT./ENGINEERING DIV.

BRIARWOOD AND N. 3RD ALLEY CONSTRUCTION STANDARD TRAFFIC CONTROL NOTES & DETAILS

DESIGNED BY: D. MUNDSCHENK HORIZ. SCALE: 1:40 DRAWING NAME: VERT. SCALE: NONE DRAWN BY: D. MUNDSCHENK 5006 CHECKED BY: C. THOMAS DATE: 7/2020

